

30 July 2018

Please Quote: 6218101
Doc Ref: RDC - 847001
Enquiries to: Lewis Stevenson

Civic Centre
1061 Haupapa Street
Private Bag 3029
Rotorua Mail Centre
Rotorua 3046
New Zealand

HUMES PIPELINE SYSTEMS
PO BOX 755
ROTORUA 3040

Attn: Dave Casey

Dear Sir / Madam,

RESOURCE CONSENT

Approved...30.July.2018.....
Appn No.....16263.....
Plan No.....
Date.....30.Jul.2018.....

NOTICE OF RESOURCE CONSENT DECISION

Consent no:	RC16263
Property file no:	P19257
Applicant:	MR RAYMOND PAUL FREEMAN
Type of application:	LAND USE CONSENT – RESTRICTED DISCRETIONARY
Proposal:	INSTALL A CONCRETE BRIDGE.
Site address:	460 PARADISE VALLEY ROAD
Legal description:	LOT 4 DPS10836

I wish to advise that the following decision has been made under authority delegated to staff in respect of the above application:

- (a) Pursuant to Section 95A of the Resource Management Act 1991, the Rotorua District Council has decided in its discretion not to publicly notify the application. Council is satisfied after due consideration of Section 95D that the adverse effects on the wider environment will be or are likely to be no more than minor. Council is also satisfied that no special circumstances exist that require notification of the consent application in accordance with Section 95A(4).
- (b) The Council has decided after taking into due consideration the requirements of Sections 95B and 95E of the Resource Management Act 1991 that the adverse effects of the activity on the owners and occupiers of adjacent land are less than minor and no persons are considered affected and therefore limited notification is not required.
- (c) Pursuant to Sections 34A, 104, 104C and 108 of the Resource Management Act 1991, the Rotorua District Council resolves to GRANT consent subject to the following conditions:

CONDITIONS OF CONSENT:

1. The proposal shall proceed in accordance with the application submitted by MR RAYMOND PAUL FREEMAN numbered RC16263 by Council except where modified by any conditions of this consent.

Engineering

2. That all engineering works required to be undertaken to satisfy the conditions of this consent shall be carried out in accordance with the Rotorua Civil Engineering Industry Standard (RCEIS) and the District Plan, to the satisfaction of the General Manager Infrastructure, Rotorua District Council or their delegate.

Sediment and erosion control

3. That in carrying out the proposed works no run off, silt, sediment, dust or other materials shall be permitted to discharge off-site that could damage or disturb neighboring properties, public roads, drains or waterways. This shall be achieved by installing and maintaining appropriate erosion, sediment and dust controls (in accordance with the Bay of Plenty Regional Council Sediment and Erosion Control Guidelines) prior to and during the works until the site is stabilised to the satisfaction of the General Manager Infrastructure, Rotorua District Council or their delegate.

Access

4. That the vehicle crossing providing access to the proposed bridge shall be constructed so as to comply with RCEIS RD22 standards to the satisfaction of the General Manager Infrastructure, Rotorua District Council or their delegate.

REASONS FOR COUNCIL DECISION:

1. Principal Issues - Earthworks within 25 metres of a waterbody can have potential impact on water quality and visual amenity.
2. Main Findings of Fact - The subject site is located at 460 Paradise Valley Road, and legally described as Lot 4 DPS 10836. The property includes an area of approximately 40.38 hectares and zoned Rural 1 and Water 1 under the Operative District Plan.

The Ngongotaha Stream dissects the subject site on the southern tip of the site. The existing access way to the subject site is located approximately 40m north of where the Paradise Valley Spring and the Ngongotaha Stream meet which is no longer in use.

The applicants seek to construct approximately 60m of private road (from a new proposed access way directly adjacent to the "Paradise Valley Park" which is currently an existing farm gate) and a single span bridge across the Ngongotaha Stream approximately 10m in length. This road and bridge is required for vehicles to gain access to the subject site for general farming purposes as the original access was destroyed in a storm event. The proposed activity will require earthworks within 25 metres of a waterbody. In accordance with the Operative Rotorua District Plan the proposed activity is a Restricted Discretionary Activity.

3. The site is zoned Rural 1 in the Operative Rotorua District Plan where earthworks not complying with Appendix 10 is a RESTRICTED DISCRETIONARY ACTIVITY.
4. The proposal is considered to be consistent with Part II of the Resource Management Act 1991.

5. The Council has had regard to the provisions of the Operative Rotorua District Plan and in particular to Appendix 10 – Earthworks. The proposal is consistent with the relevant objectives and policies of Part 10 – Rural of the Operative Rotorua District Plan subject to compliance with the conditions of consent.
6. The Council is satisfied that the proposed activity will not have, or is unlikely to have, any adverse effects that are more than minor.
7. No persons are considered adversely affected by the proposal.
8. Conditions have been imposed in order to mitigate the adverse effects of the proposal such that they are no more than minor.
9. The applicant has applied for resource consent from the Bay Of Plenty Regional Council for earthworks to install a new bridge adjacent and over the Ngongotaha Stream.
10. This consent is for a private bridge on private land.
11. No services are required.
12. A new vehicle crossing will be required to be constructed to RD22 RECIS standards.
13. The sight distances are adequate for the the vehicle crossing at this location, as the traffic travelling at a slow enough speed (approx: 50 to 60kmh) due to the approach or departure from the existing public bridge and corners.

The applicants are advised that:

- (a) Timeframe for Giving Effect to this Consent
The above consent lapses on the expiry of 5 years after the date of receiving this letter, unless the consent is given effect to.
- (b) Right of Objection
If you are dissatisfied with any aspect of the decision, you have a right of objection to Council under section 357A of the Resource Management Act 1991. Please advise Council in writing stating the reasons for the objection and the preferred outcome within 15 working days of receiving this decision. If no objection is received it will be assumed that the applicant accepts this decision. In addition, there is a right of appeal to the Environment Court under section 120 of the Resource Management Act 1991.
- (c) Obligations under the Heritage New Zealand Pouhere Taonga Act 2014
Council has no records of an archaeological site on this property. This may be due to one of two factors. Either, there are no sites present or there has not been an archaeological survey undertaken. Please be advised that both known and unknown archaeological sites are protected under the Heritage New Zealand Pouhere Taonga Act 2014. If during the exercising of this consent any archaeological site is uncovered work must stop and permission be obtained from Heritage New Zealand under section 44 of the Heritage New Zealand Pouhere Taonga Act 2014.
- (d) Works within the road reserve

Prior to any works being undertaken within the road reserve (including vehicle crossings) a Corridor Access Request must be lodged with Council and a Works Access Permit issued. This is available free of charge by going online to the website www.beforeudig.co.nz or by contacting Council's Corridor Access Administrator on 07 351 8201.

(e) Stormwater collection & disposal

All stormwater intercepted on the works site for the proposed bridge works is to be collected in such a manner that it does not cause erosion and disposed of within the property boundary and not directly to the stream. A sediment filtration system must be used before discharge.

(f) Bay Of Plenty Regional Council Earthworks requirements

That any cut / fill earthworks to form the approaches, transitions and abutments that exceed the permitted activity criteria of Rule LM R1 (permitted earthworks) of the RNRP (formerly Rule 1 of the RWLP) require resource consent from the BOPRC.


Please contact Mary Pappon (Senior Consents Officer) at the Bay of Plenty Regional Council Toi Moana (BOPRC) for any queries regarding earthworks consent matters.

(g) Flood water clearance to underside of the bridge beam

That the new private bridge shall be constructed to provide a minimum of 0.6m clearance above the 2% AEP flood level for the Ngongotaha Stream at this location to the underside of the lowest element (Double Tee/beam) of the bridge structure as set by the Bay of Plenty regional Council.

If you have any questions regarding this decision, please contact **Lewis Stevenson**, or the duty planner.

Yours faithfully

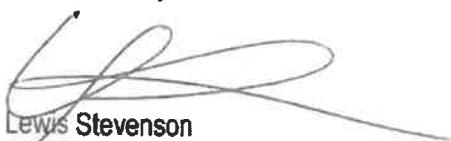

Lewis Stevenson
Consents Planner, Planning & Development Solutions

On behalf of
Simon Bell,
Team Lead Planning, Planning & Development Solutions

Site specific design

- NOTES:**

 1. EXISTING GROUNDS PROFILE FOR INDICATION ONLY. CHECK THE SITE BEFORE CONSTRUCTION. ACTUAL EARTHWORK SHOULD REFER TO THE FINAL BRIDGE LEVEL AND STREAM LEVEL ON SITE.
 2. GABION BASKETS TO BE PVC COATED FILED WITH HARD DURABLE STONE WITH A NOMINAL DIAMETER OF 100mm TO 250mm WITH NO MORE THAN 10% FINES AS PER CRITERIA INSTALLATION GUIDELINES.

OPEN BII NOTES


CAUTION NOTES:

- 250 SED HB TIMBER DRIVEN PILES
- DRIVEN PILES WITH 500kg HAMMER
- DROP HEIGHT 1000mm
- FINAL SET 14mm AVERAGE OVER THE LAST TEN BLOWS.
- MINIMUM DEPTH INTO GROUND 3000mm

CAUTION BASKET NOTES:

- 1m x 1m x 1m BASKET - 8 REQUIRED
- 1.5m x 1m x 1m BASKET - 8 REQUIRED
- 3m x 1m x 1m BASKET - 8 REQUIRED

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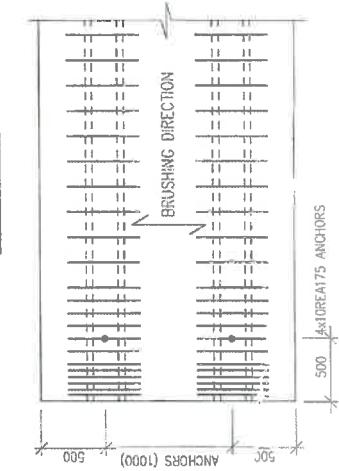


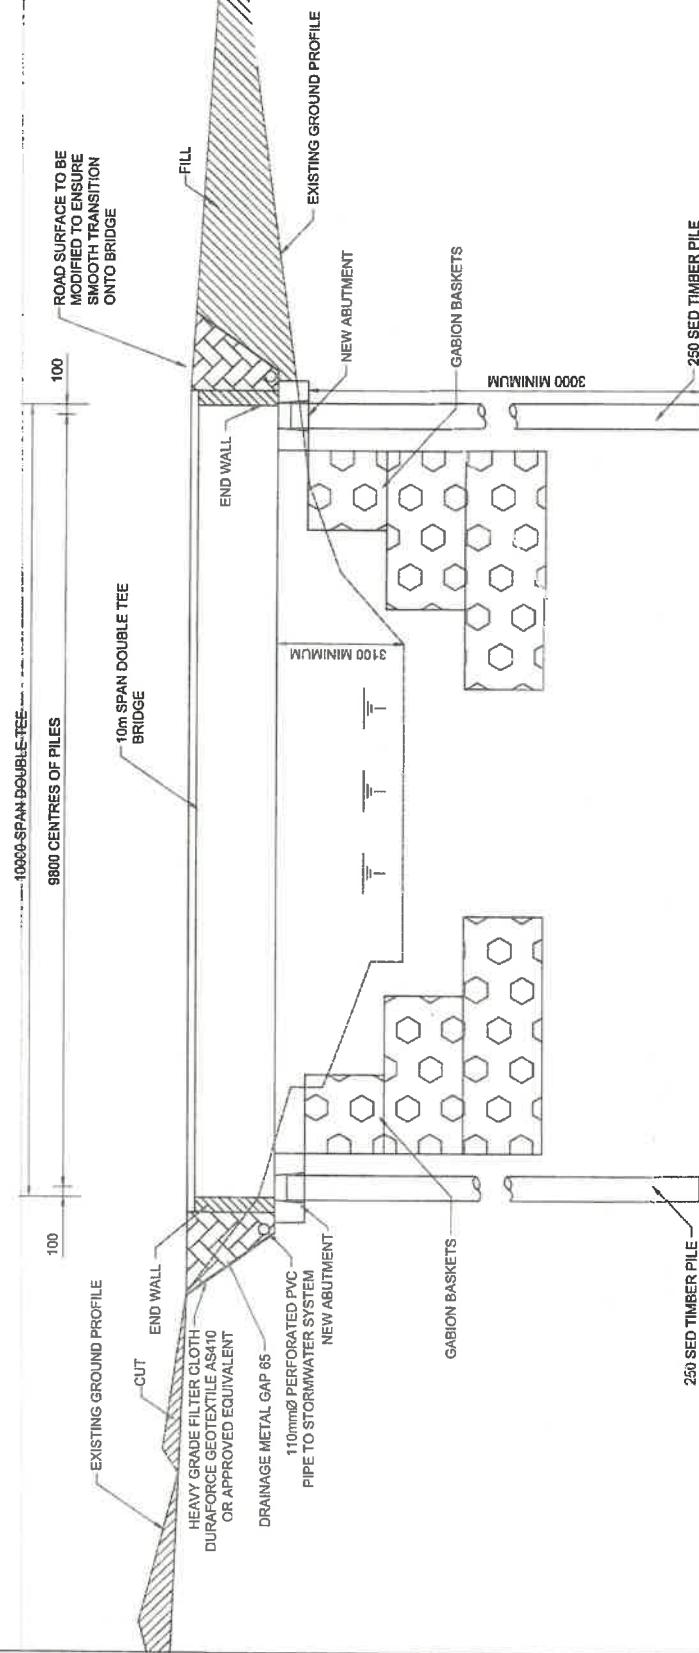CROSS SECTION


Site:	460 PARADISE VALLEY ROAD, ROTORUA		
Domestic:	TYPICAL SECTION		
Project No.	Sheet No.	Scale (Original at A3)	Rev
180022-01	03	NOT TO SCALE	01 based for construction
Client:	Dean Dinnington & Ray Freeman		
	Date:	11/05/2018	
Phoenix Consulting Engineers Ltd	Drawn:	YH	YH
	Checked:		
	Approved:		
	SN:		

FOR INFORMATION ONLY

PART PLAN VIEW OF DECK REINFORCEMENT




PART PLAN VIEW OF DECK REINFORCEMENT

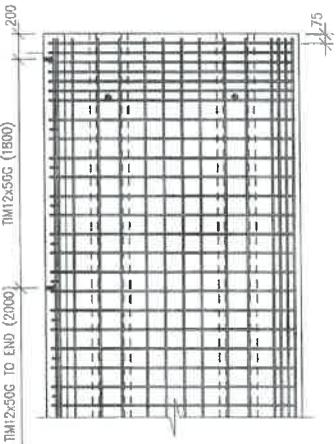


PART PLAN VIEW OF DECK REINFORCEMENT

NOTES:


1. PRECAST BRIDGE DECK DETAIL PROVIDED BY THE SUPPLIER/MANUFACTURER - HUMES® FOR INFORMATION ONLY
 2. MANUFACTURE IN ACCORDANCE WITH NZS 3195:1997 (PRECAST UNITS)
 3. CONCRETE STRENGTH @ 28 DAYS 30 MPa.
MIN. STRIPPING STRENGTH 28MPa
 4. PRESTRESSING STRANDS IN ACCORDANCE WITH AS/NZS 4672.1:2007 & AS/NZS 4672:2007
 5. REINFORCEMENT STEEL IN ACCORDANCE WITH NZS 4671 HD BARS = 500MPa WELDABLE
 6. SURFACE FINISHES TO NZS 3141:1987,
FORMED SURFACE - F4 FINISH
TOP OF KERB - U3 FINISH
DECK - U5 BROOM FINISH
 7. INITIAL STRESS RATIO Po/Pu 73%
 8. CONCRETE COVER 50mm FOR DECK &
25MM F-OR WEB STEEL U.N.O
MASS PER METRE 1.232T/1000MM
BRIDGE DECK 10m:
WEIGHT = 12.47t
VOLUME = 4.98m³
KERB 10m:
WEIGHT = 0.852t
VOLUME = 0.348m³

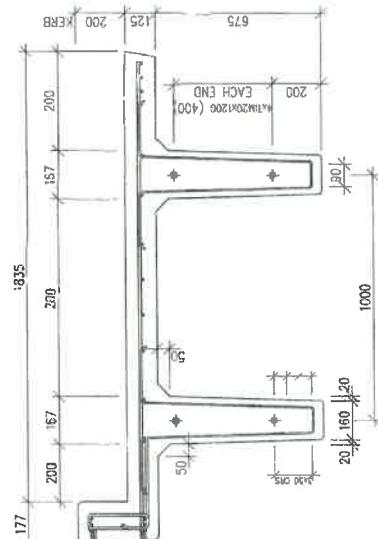


DECK SECTION

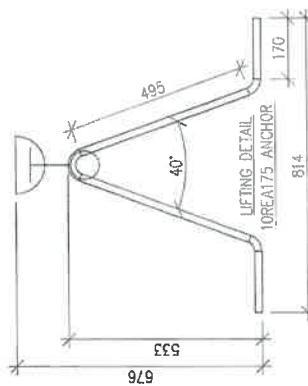

NOTES:
 1. MANUFACTURE IN ACCORDANCE WITH
 NZS 3108:1987 (PRECAST UNITS)
 2. CONCRETE STRENGTH @ 28 DAYS 30MPa,
 MIN. STRIPPING STRENGTH 20MPa
 3. REINFORCEMENT STEEL IN
 ACCORDANCE WITH NZS 3422 & 3402
 HD BARS = 500MP WELDABLE
 4. SURFACE FINISHES TO NZS 3114:1987,
 FORMED SURFACE - F4 FINISH
 TROWELED FINISH - U3 FINISH
 CONCRETE COVER 35mm UNLESS
 OTHERWISE NOTED
 5. EXPOSURE: B1/B2

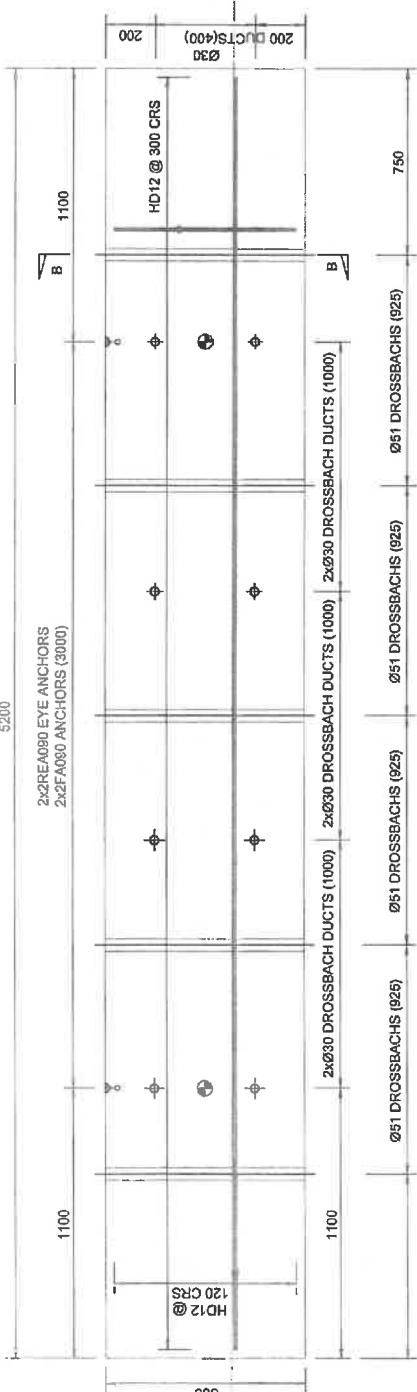

END WALL DETAILS
SCALE 1:20

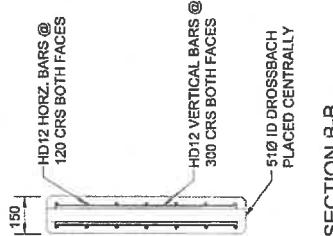


SECTION B-B
SCALE 1:20



SIGN REQUIRED EACH END


Site:	Project No.	Sheet No.	Scale (Optional at A3):	Rev:	Description	Date	Drawn	YH
460 PARADISE VALLEY ROAD, ROTORUA	180022.01	05	1:20	01	Issued for construction	YH	11-May-16	
Detail:								Checked
END WALL DETAIL								YH
								Approved
								SN



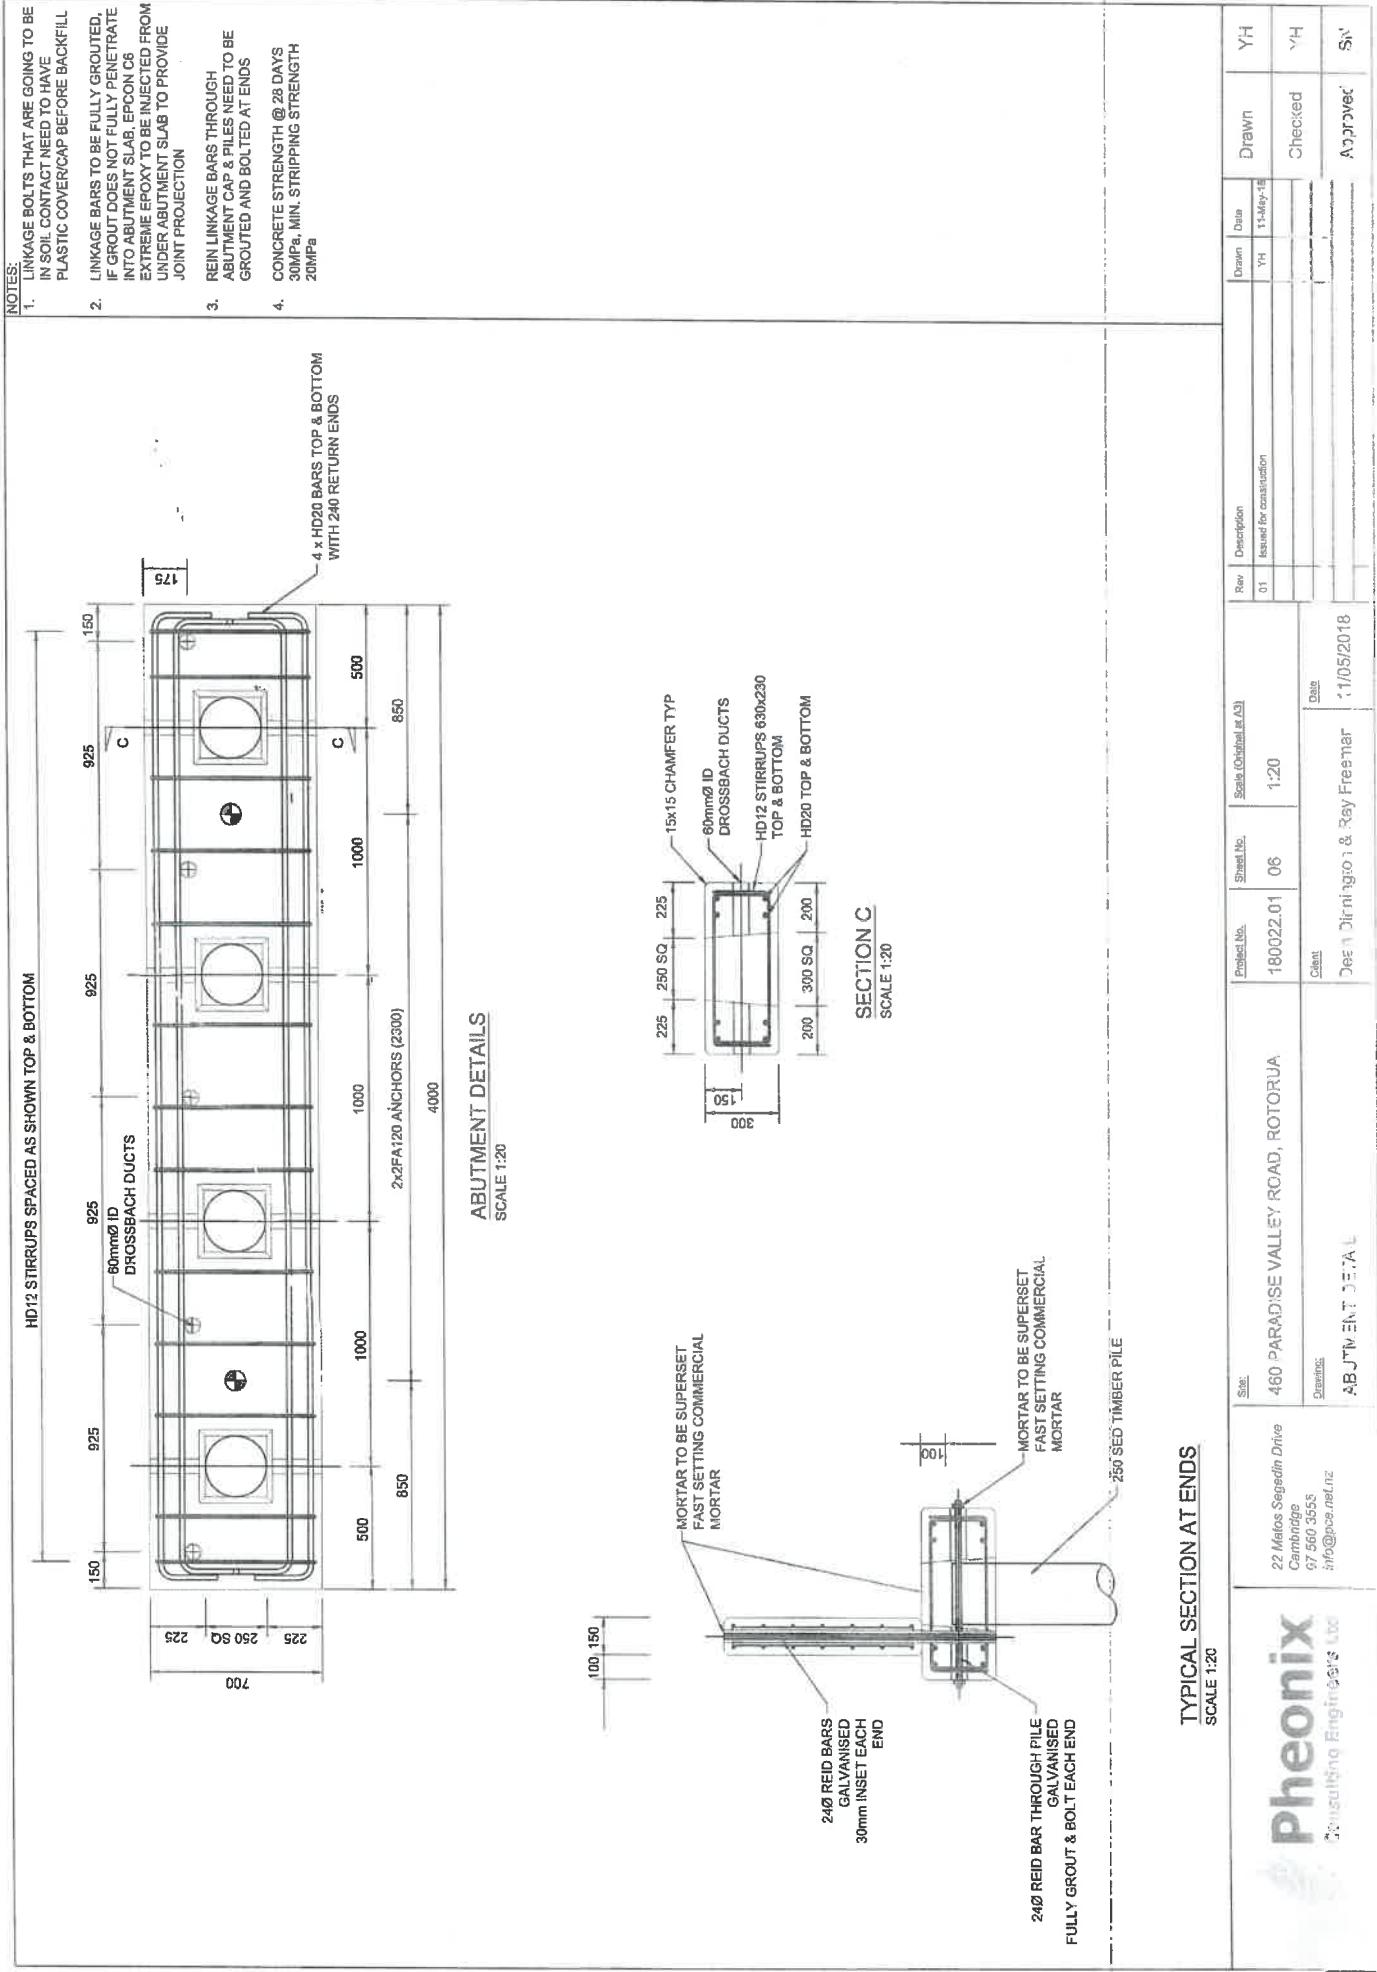

NOTES:

1. LINKAGE BOLTS THAT ARE GOING TO BE IN SOIL CONTACT NEED TO HAVE PLASTIC COVERCAP BEFORE BACKFILL
2. LINKAGE BARS TO BE FULLY GROUTED. IF GROUT DOES NOT FULLY PENETRATE INTO ABUTMENT SLAB, EPONC C6 EXTREME EPOXY TO BE INJECTED FROM UNDER ABUTMENT SLAB TO PROVIDE JOINT PROJECTION
3. REINLINKAGE BARS THROUGH ABUTMENT CAP & PILES NEED TO BE GROUTED AND BOLTED AT ENDS

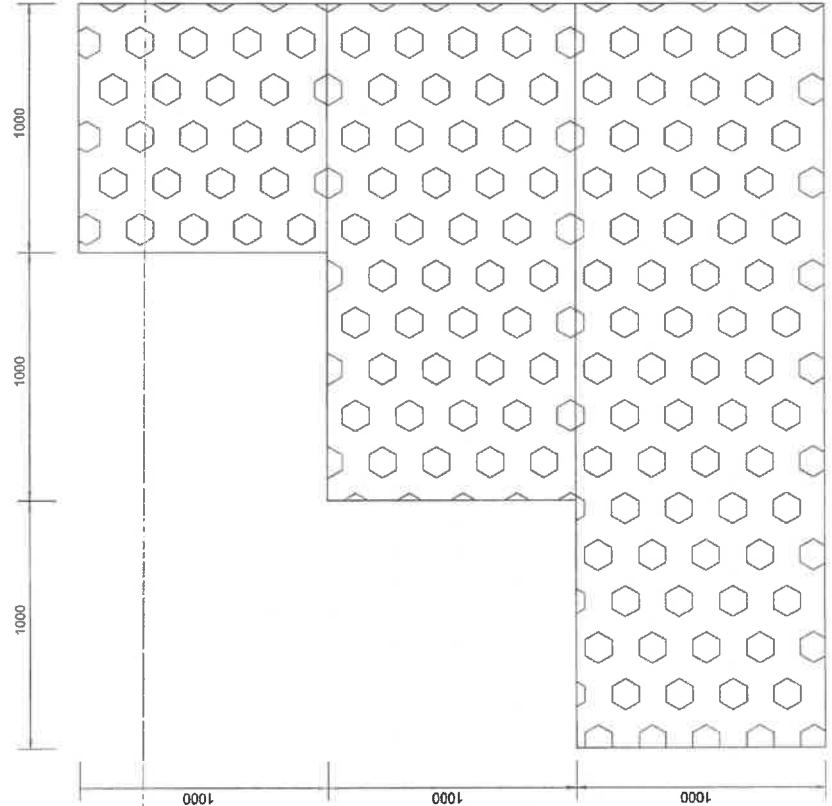

GABION BASKET SECTION


Project No.	Sheet No.	Scale (Original is A3)	Rev.	Description	Drawn	Date	YH
180022.01	07	1:20	01	Issued for construction	YH	11-May-18	Checked
							Approved SN

Sheet
Drawing:
GABION BASKET DETAIL
Dean Dimmington & Ray Freeman
11/05/2018



NOTES:

1. RIPRAP OR LARGE ROCK TO MATCH SITE CONDITIONS

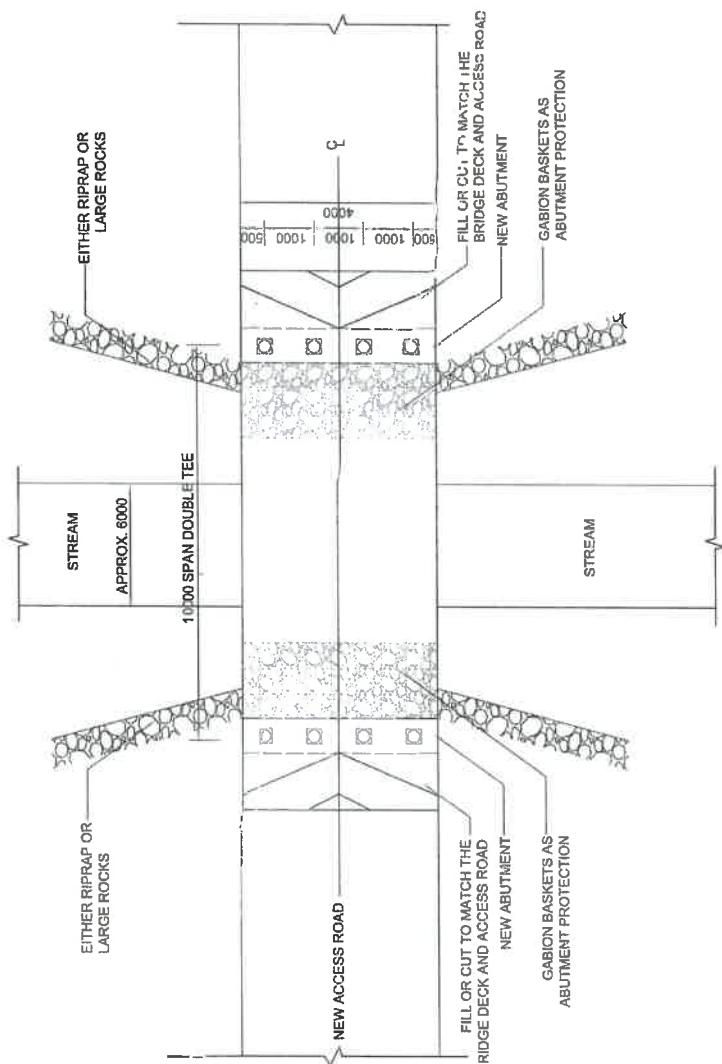


PLAN VIEW

Project No.	Sheet No.	Scale (Original or As Drawn)	Rev.	Description	Drawn	Date	YH
180022.01	02	NOT TO SCALE	01	Issued for construction	YH	11-May-18	
							Checked
							Approved
							Sign.

Site: 460 PARADISE VALLEY ROAD, ROTORUA
22 Matos Segebin Drive
Cambridge
07 960 3555
info@phenonix.co.nz
T: +64 21 301 832
E: ray.farman@phenonix.co.nz

Drawn:
Des.: Dir.: C.: G.: S.: Ray Farman
Date: 11/5/2018

Phenonix
Structural Engineering

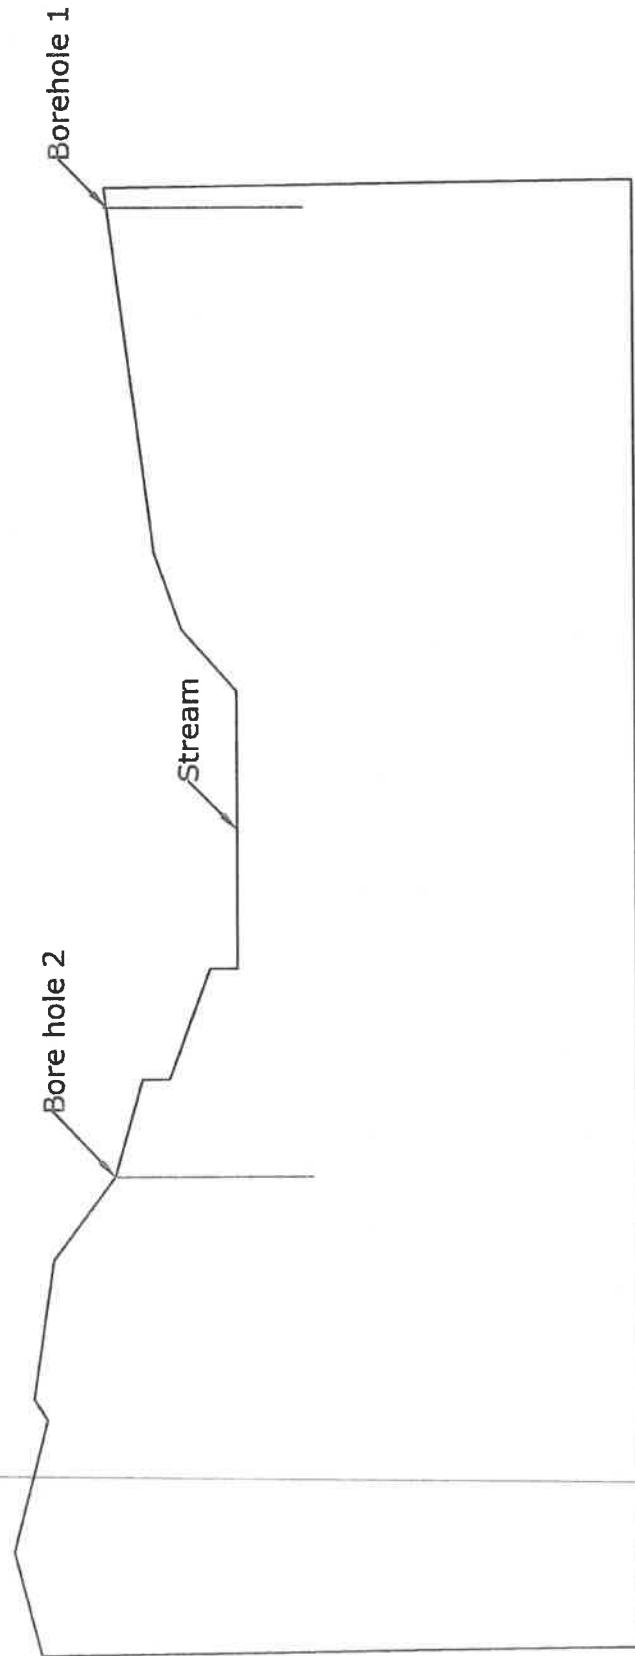

Site:		460 Paradise Valley Springs, Rotorua		Drawn:	Date:		
Drawing:		Project No.	180022	H-J	15/03/2018		
Phoenix		Scale:	1:100			Rev	Description
Consulting Engineers Ltd	22 Meiros Sagedin Drive Cambridge 07 560 3555 info@pce.net.nz						

FOR INFORMATION ONLY

PART PLAN

PART D: AN

TM12x50G TO END (2000) TM12x50G (1800) 200

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A technical drawing of a foundation wall section. The wall is 500 units wide and 1000 units high. It features vertical dashed lines representing rebar and horizontal dashed lines representing anchors. A label 'ANCHORS (1000)' is at the bottom right. An arrow labeled 'BRUSHING DIRECTION' points upwards along the left side of the wall. A dimension line indicates a height of 500 from the base to the top of the wall. On the right side, there is a label '4x10REA175 ANCHORS'.


MASS PER METRE = 1.523 TONNE
BRIDGE DECK 10m = 12.471 TONNE
VOLUME 4.96m³
KERB 10m = 0.652 TONNE

BRIDGE DECK 10m = 12.47TONNE
KERB 10m = 0.852TONNE

500 4x10#E175 ANCHORS

NOTE

- | | |
|---|-----------------------------------------------------------------------------------------------------------------------|
| 1 | MANUFACTURE IN ACCORDANCE WITH
NZS 3109:1997 (PRECAST UNITS) |
| 2 | CONCRETE STRENGTH @ 28 DAYS
50MPa, MIN. STRAPPING STRENGTH 25MPa |
| 3 | PRESTRESSING STRANDS IN ACCORDANCE
WITH AS/NZS 4672.1:2007 &
AS/NZS 4672.2:2007 |
| 4 | REINFORCEMENT STEEL IN ACCORDANCE
WITH NZS 4671
HD BARS = 500MPa WELDABLE |
| 5 | SURFACE FINISHES TO NZS 3141:1987,
FORMED SURFACE - F4 FINISH
TOP OF KERB - U3 FINISH
DECK - U5 BROOM FINISH |
| 6 | INITIAL STRESS RATIO σ_0/σ_u 73% |
| 7 | CONCRETE COVER 50mm FOR DECK &
25mm FOR WEB STEEL LINO |

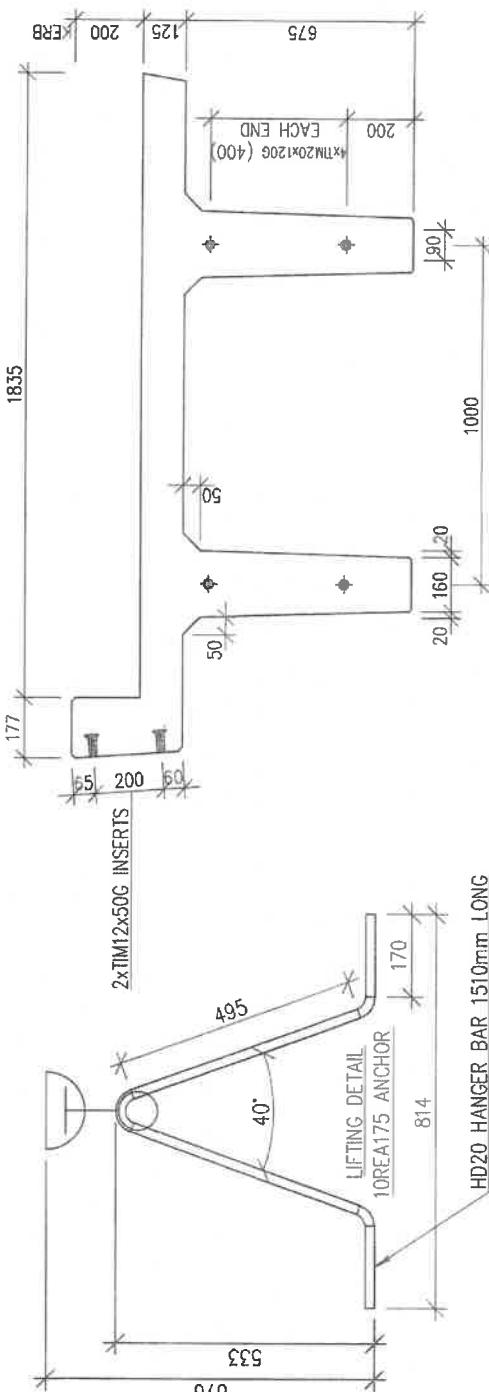

<p>This drawing is the property of Fletcher Concrete & Infrastructure Limited and is subject to return upon demand. It is submitted for use only in connection with proposals and contracts of Humes Pipeline Systems, a division of Fletcher Concrete & Infrastructure Limited upon the express condition that it is not to be reproduced or copied in any form. Data is to be used only with reference to products manufactured and supplied by Humes Pipeline Systems, a division of Fletcher Concrete & Infrastructure Limited.</p>	 <p>Humes Pipeline Systems</p> <p>Private Bag 9287 Auckland Freephone 0800 502 112 www.humes.co.nz</p>	<p>CODE: 04978</p>
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Drawn By	Product Code	Bridge Deck	Details On SHEET NO. 3\11	Date Drawn	08-11-13
Check No.	Code	04578	Scale	NTS	Checked by
				JN	Approved by
	Project Name				W.L.
					Eff. Job No. H131204.03
					Cooling No. 04978
DOUBLE TEE BRIDGE DECK			10 METRE SPAN SALES		
Drawn Date	ELEVATIONS				

Drawn By	Product Code	Bridge Deck	Details On SHEET NO. 3\11	Date Drawn	08-11-13
Check No.	Code	04578	Scale	NTS	Checked by
				JN	Approved by
	Project Name				W.L.
					Eff. Job No. H131204.03
					Cooling No. 04978
DOUBLE TEE BRIDGE DECK			10 METRE SPAN SALES		
Drawn Date	ELEVATIONS				